



Proposed Front Elevation

Scale 1:50



Proposed Side Elevation

Scale 1:50

The contractor is to check and verify all building and site dimensions, levels, and sewer invert levels at connection points before work starts.

This drawing must be read with and checked against any structural or other specialist drawings provided.

Any discrepancies found on this drawing are to be notified to STONE ME! DESIGN LTD prior to commencement of work.

The contractor is to comply in all respects with the current Building Regulations whether or not specifically stated on these drawings.

This drawing is not intended to show details of foundations or ground conditions. Each area of ground relied upon to support the structure depicted must be investigated by the contractor and suitable methods of foundations provided.


This drawing is to be read in conjunction with all other standard STONE ME! DESIGN LTD specifications and documentation.

STONE ME! DESIGN LTD reserves the right to withdraw any drawings from any applications or third parties should disputes arise between the client and STONE ME! DESIGN LTD.

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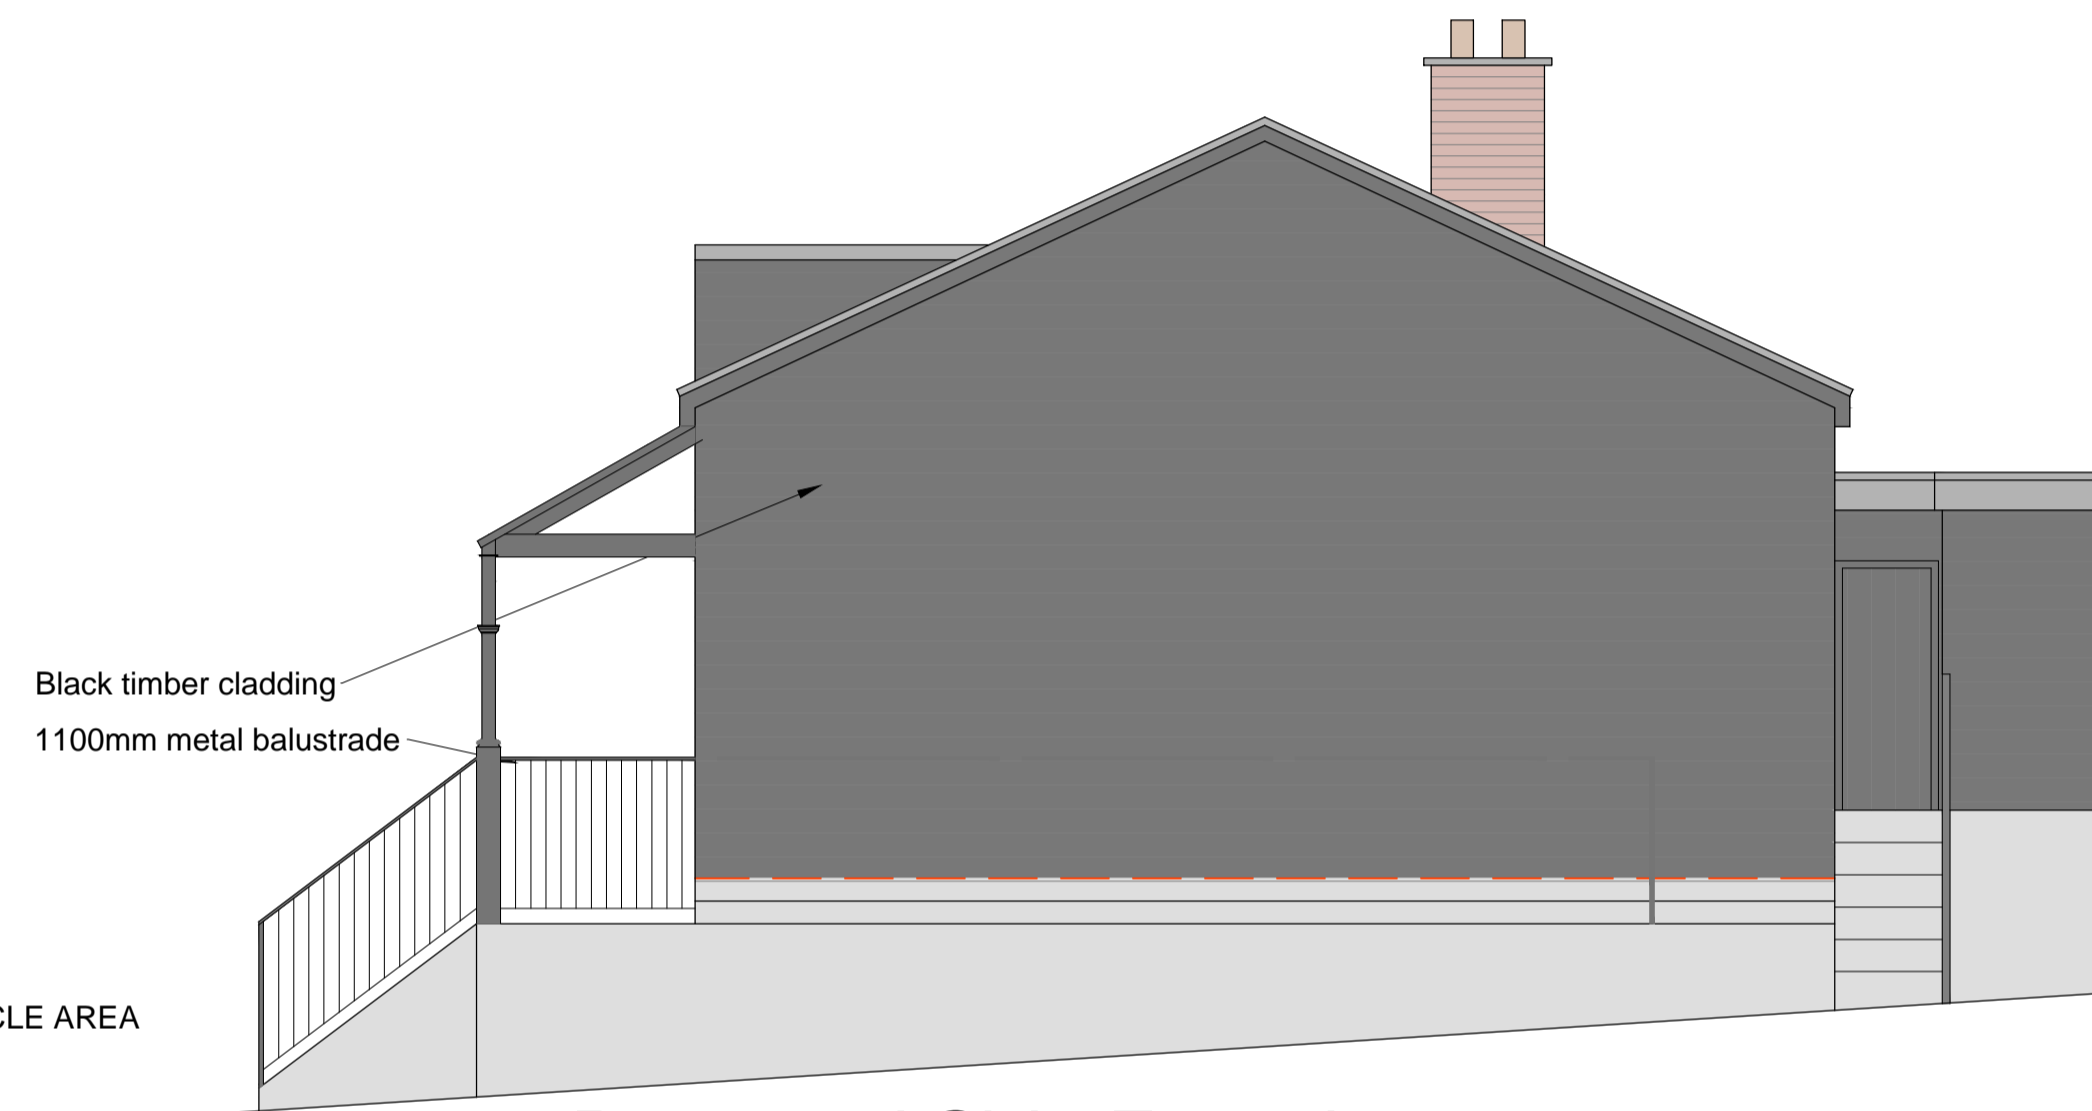


Proposed Logo Design

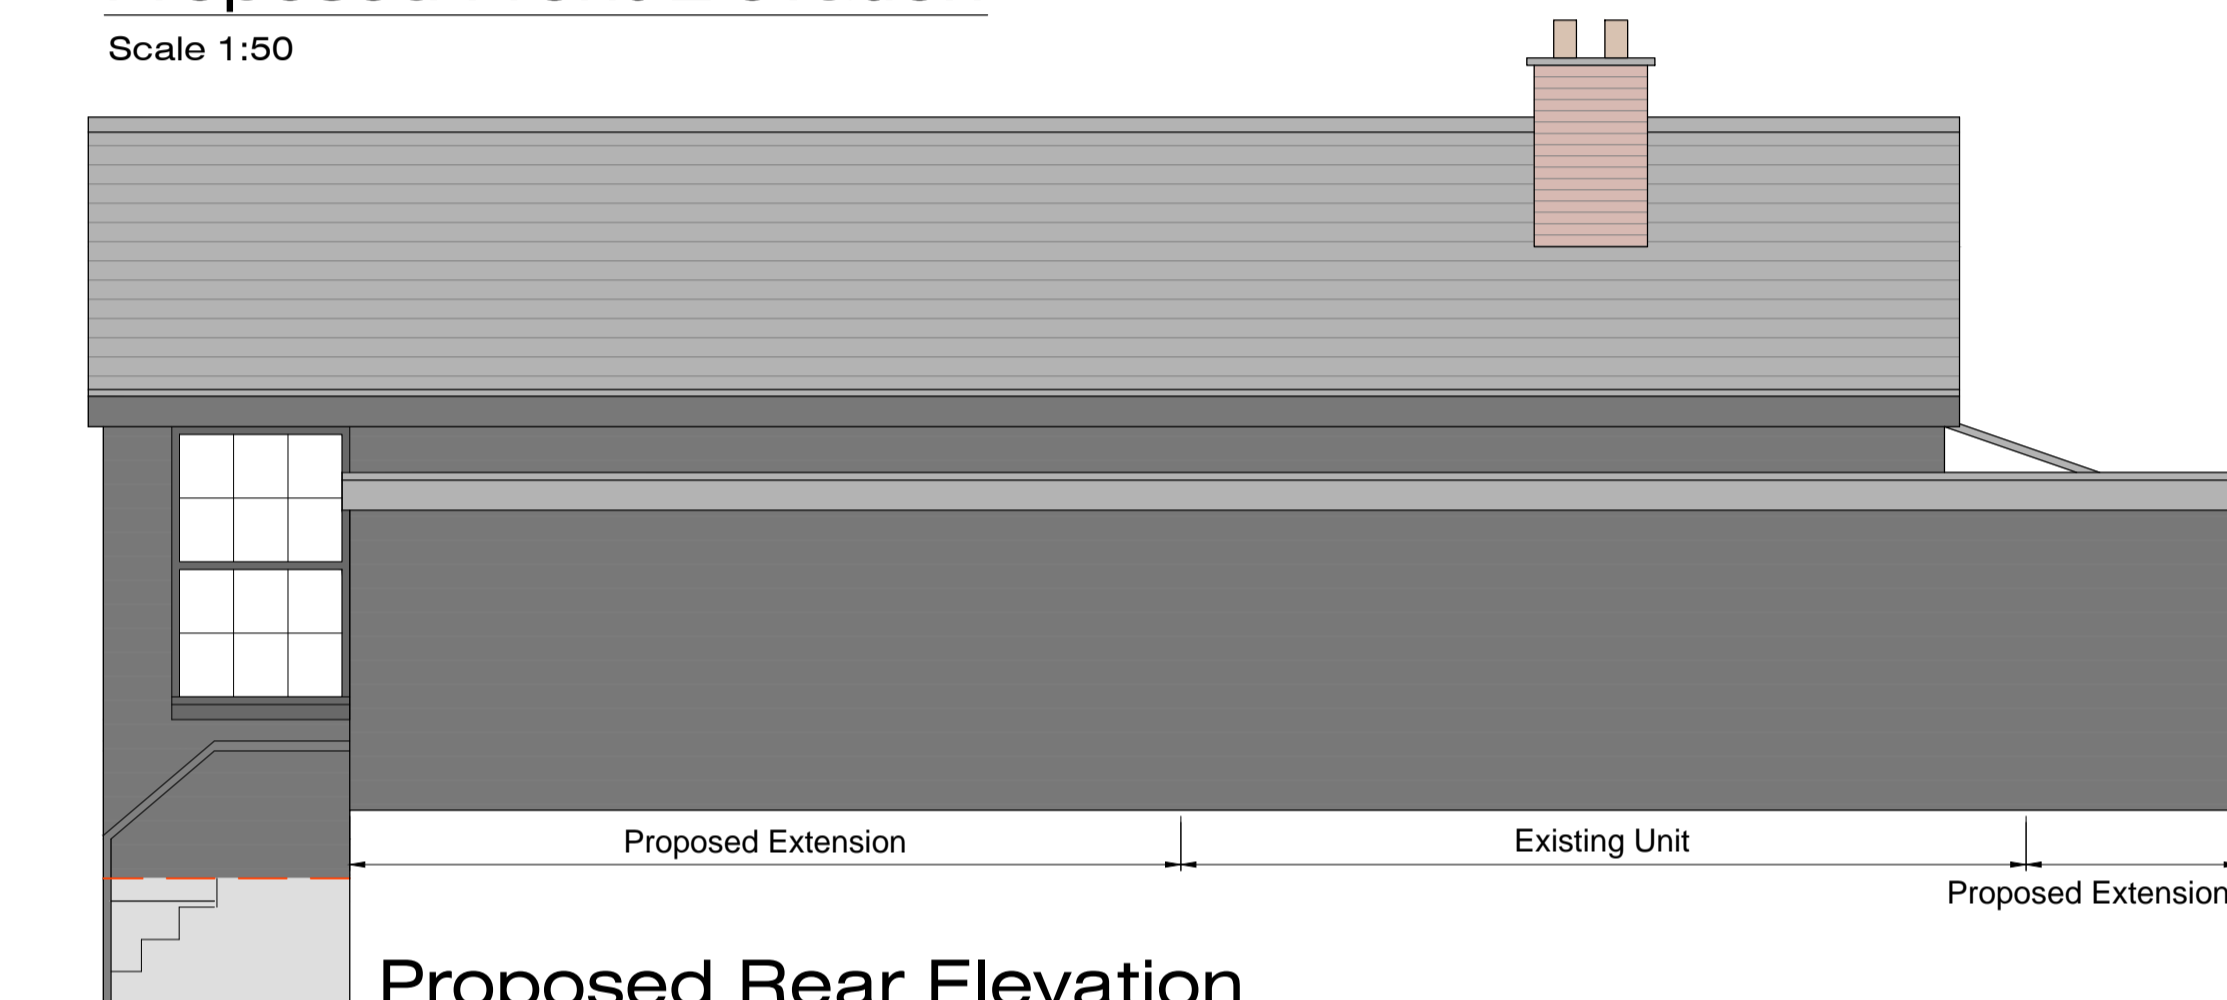

Proposed Rear Elevation

Scale 1:50



Proposed Side Elevation

Scale 1:50



Proposed Ground Floor Plan

Scale 1:50

REV:	DATE:	AMENDMENT:
STONE Me! ARCHITECTURE & INTERIOR DESIGN 5 FOUNTAIN LANE, HOCKLEY, ESSEX, SS5 4ST Tel: 01702 203333 E: info@stoneme.com W: www.stoneme.com		
Client:	MR J BATSON	
Project:	Scout Hall 52 High Street Leigh-On-Sea, Essex, SS9 2EP	
Drawing:	PROPOSED FLOOR PLANS AND ELEVATIONS - PLANNING	
Issue:	Client	Pre-App Planning B.Cont As Built Other
Date:	15.07.2020	Scale: 1:50 @ A1
Project No.:	1920	Drawing No.:
		02G

1:100
0m 1 2 3 4 10.0m