


1 Proposed Floor Plan
Scale: 1:100 A1



2 Proposed Roof Plan
Scale: 1:100 A1

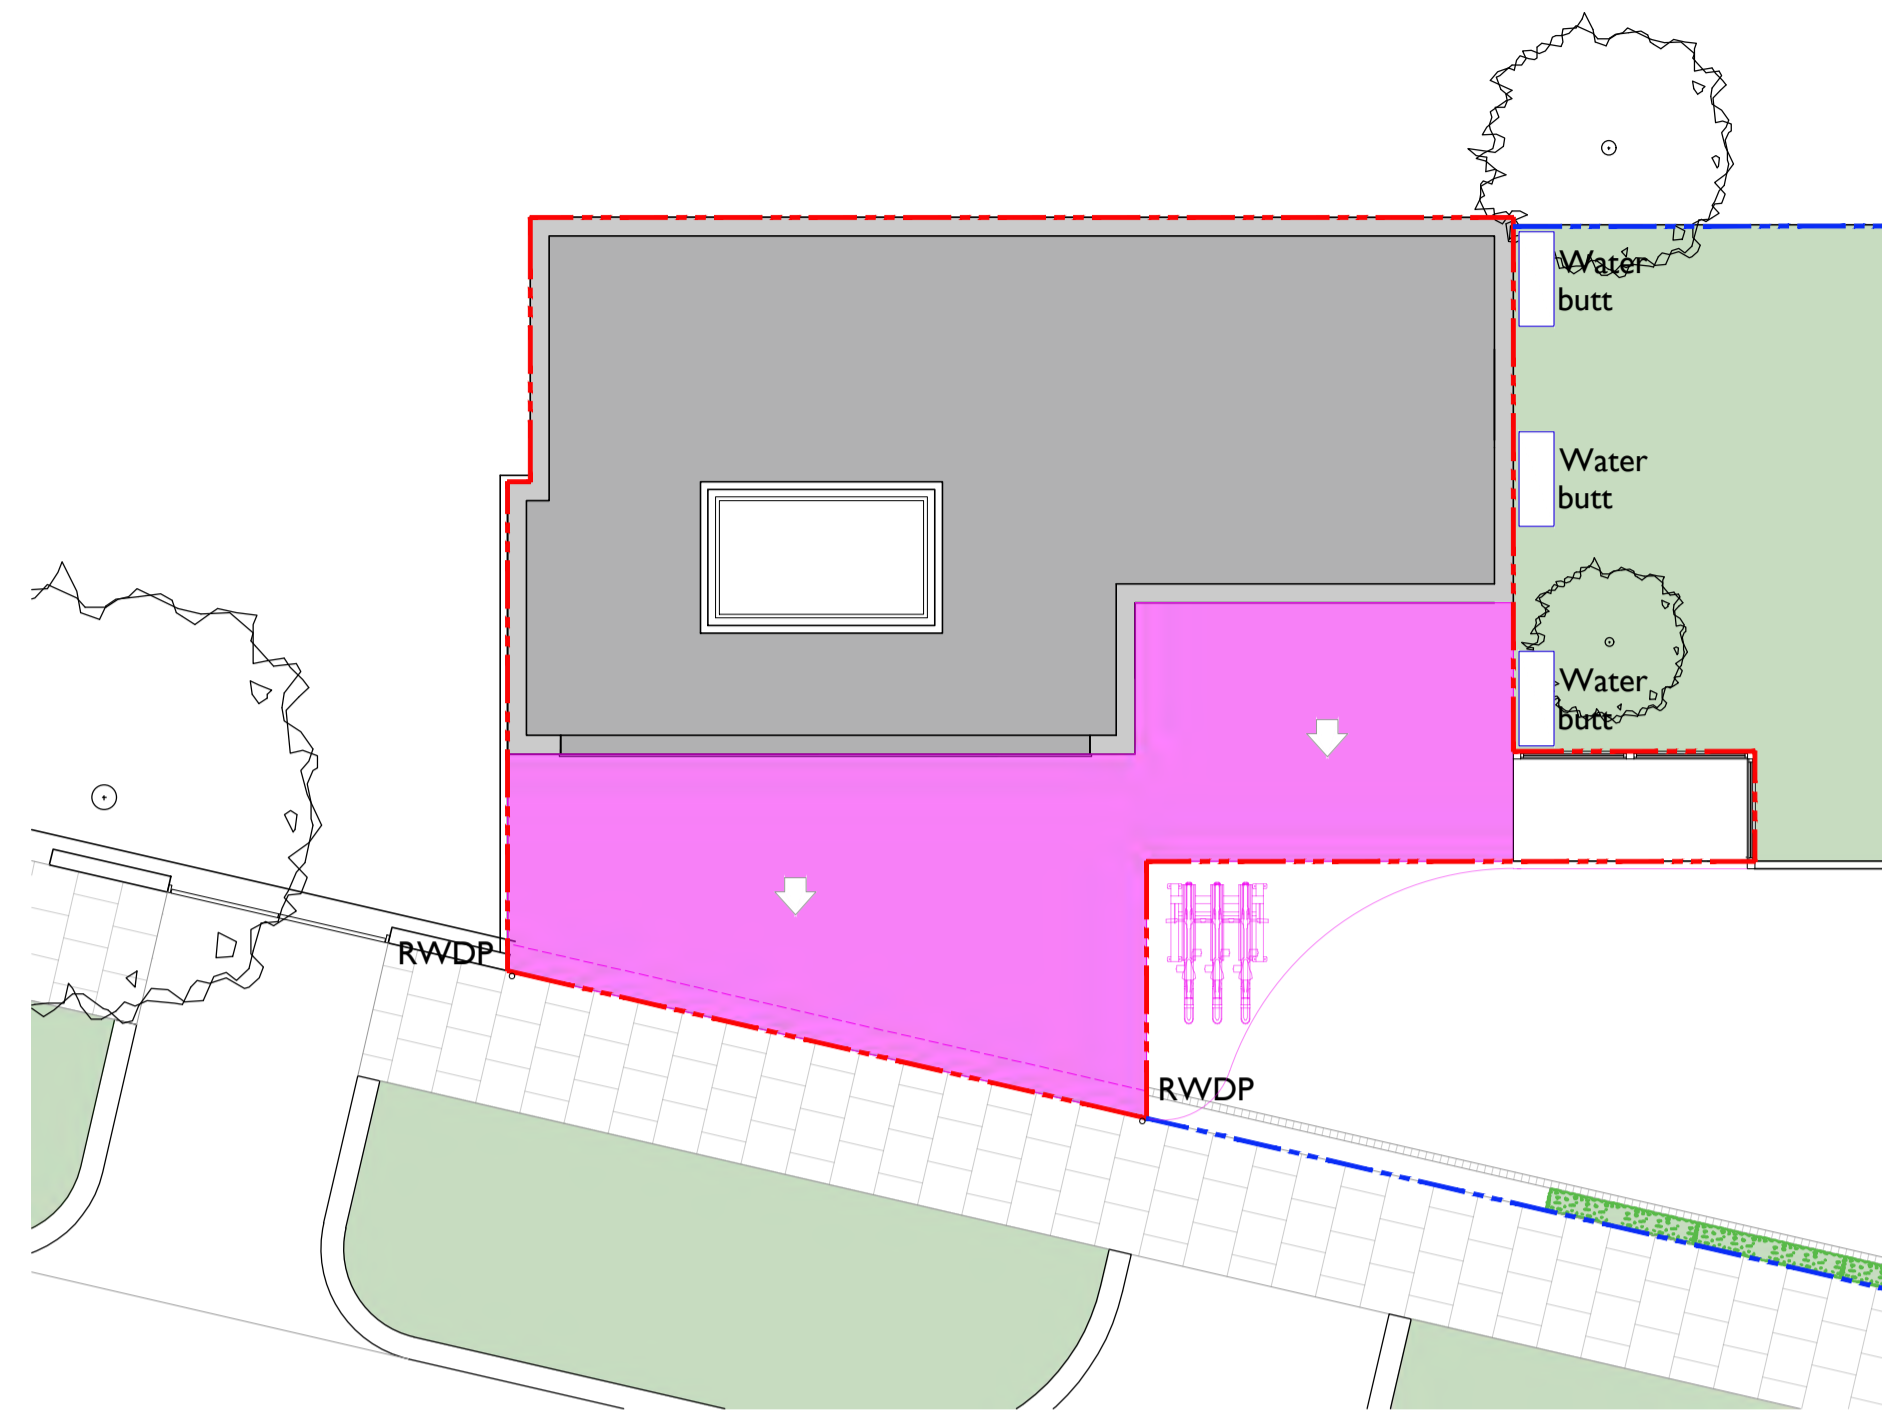


3 Proposed Front Elevation
Scale: 1:100 A1



5 Proposed Right Side Elevation
Scale: 1:100 A1



7 Proposed Isometric Projection Views

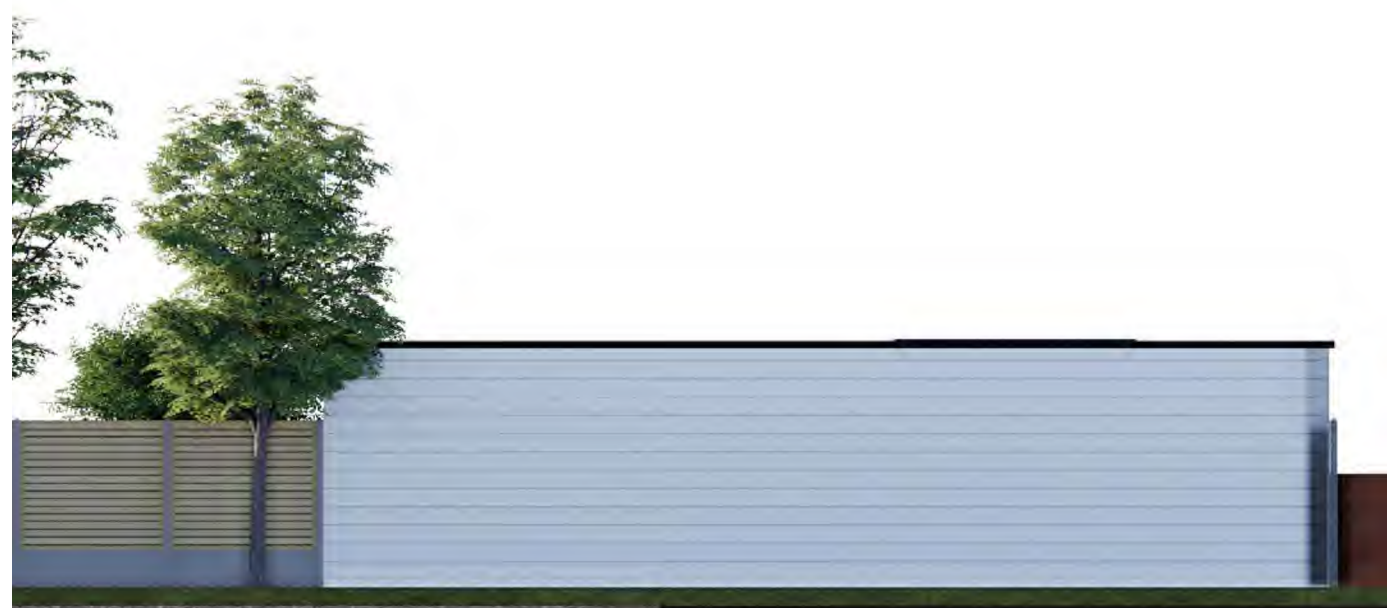


4 Proposed Rear Elevation
Scale: 1:100 A1



6 Proposed Left Side Elevation
Scale: 1:100 A1

0 1m 2m 3m

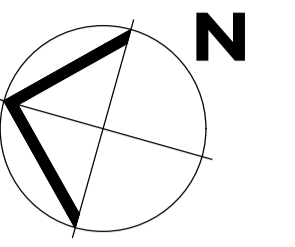

Revision	Date	Description
C	18-10-2024	Updated high level window
B	01-10-2024	Updated door and cycle spaces
A	19-09-2024	Updated Drainage information

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The sizing of all structural and service elements must always be checked against the relevant engineers drawings. No reliance should be placed upon sizing information shown on this drawing.

Project

97-99, 101 Shaftesbury Avenue
Southend-on-Sea, SSI 3AN

Drawing Title
Proposed Plans, Elevations and Projection Views

Drawing Number	Revision
DGA-SA-PL-ARC-LP-101	C
Scale	Revision Date
1:100 A1	Jul 2024

Drawing Purpose
Planning

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Scale 1:100
0 1 2 3 4 5 6 7 8 9 10(m)